150 S State Street

Ph. 801.864.1761

Ph. 801.487.8040

Salt Lake City, UT 84102

PROJECT TEAM

PROJECT OWNER

Mary Jane Fine mjfine@unphe.org 1072 S Jeremy Street Salt Lake City, UT 84104 Ph. 801.301.1891

CIVIL ENGINEER 3RD PARTY BUILDING INSPECTOR WARD ENGINEERING FORSGREN BUILDING INSPECTION John Bond Attn: Curt Allen ICC Certification #: 1016602 jbond@wardeng.com 231 W 800 S, Ste. A curtallenwbi@gmail.com Salt Lake City, UT 84101

MODULAR BUILDING MANUFACTURER RANGE Architecture + Design LiveModal Attn: Andrea Palmer andrea@livemodal.com

Attn: Ian Kaplan ikaplan@rangearchitecture.com 1068 E 2100 S Salt Lake City, UT 84106 Ph. 585.261.1856

PROJECT ARCHITECT

STRUCTURAL & M.E.P. ENGINEERS GENERAL CONTRACTOR CLASSIC EXCAVATION, LLC EPIC Engineering Attn: John Riley RUSSELL D. JOLLEY russdjolley@hotmail.com jriley@epiceng.net 4297 SCENIC ACRES DRIVE 3341 S 4000 W, Suite D RIVERTON, UT 84096 West Valley City, UT 84120

GENERAL NOTE MODULAR UNIT TO BE PRE-MANUFACTURED IN FACTORY. ALL APPLICABLE THIRD PARTY INSPECTIONS & REPORTS TO BE COORDINATED WITH THE AUTHORITY HAVING JURISDICTION AND PROVIDED BY MODULAR BUILDING MANUFACTURER

Ph. 435.654.6600

VICINITY MAP

Ph. 801.487.8040



SHEET INDEX

GENERAL	GENERAL	
G001	TITLE SHEET, SITE PLAN	
G002	NOTES, ABBREVIATIONS, SYMBOLS, GENERA NOTES	
G003	ASSEMBLIES	

C0.0 CERTIFIED SURVEY GENERAL NOTES

STRUCTURAL PLANS S1.0 DETAILS S1.1

FLOOR PLAN, ROOF PLAN, INTERIOR **ELEVATIONS** FINISH & REFLECTING CEILING PLANS,

SCHEDULES **BUILDING ELEVATIONS & 3D VIEWS** BUILDING SECTIONS **BUILDING DETAILS**

MECHANICAL

MECHANICAL GENERAL NOTES FIRST LEVEL MECHANICAL PLAN, DETAILS &

PLUMBING

PLUMBING GENERAL NOTES PLUMBING & SANITARY PLANS, DETAILS & SCHEDULES

ELECTRICAL

ELECTRICAL SYMBOLS & NOTES ELECTRICAL GENERAL NOTES ELECTRICAL & LIGHTING PLAN ELECTRICAL DETAILS

Ph. 385.218.7446

PROJECT INFORMATION

ADDRESS: 1072 S Jeremy St. Salt Lake City, UT 84104 PARCEL RECORD #: 15114040120000

AUTHORITY W/ JURISDICTION: Salt Lake City SITE AREA: .21 ACRES (9,013 SF)

MODULAR DETACHED ACCESSORY DWELLING UNIT TO **DESCRIPTION:**

BE ADDED TO EXISTING SINGLE FAMILY RESIDENCE

CONSTRUCTION TYPE: VB (WOOD FRAME)

ZONING INFORMATION

R-1-5000 - 21A.24.070

	REQUIRED	COMPLIANCE
SURFACE COVERAGE:	40% MAX	YES
Lot Size:	9,013 SF	
Structure Coverage:		
Existing House:	1,009 SF	
Existing Garage:	581 SF	
New ADU:	425 SF	
Total:	2,015 SF (22%)	

ACCESSORY DWELLING UNITS - 21A.40.200

	REQUIRED	COMPLIANCE
PARKING:	*1	YES
	*Not required if 1/4 mile from mass transit	
	*On street parking may comply	
SIZE:	50% of existing dwelling area	YES
Existing House:	1,009 SF	
Proposed ADU:	425 SF (42% of existing)	
	< 650 SF?	YES
SURACE COVERAGE	50% MAX OF REAR YARD	YES
Rear Yard Size:	4,525 SF	
Structure coverage:		
Existing Garage:	581 SF	
Existing Shed:	85 SF	
New ADU:	425 SF	
Total:	1,091 SF	
SETBACKS (DETACHED ADU	J):	
From S.F.R.	10'	YES
Side:	*4'	YES
	*10' Required if unit faces side property	
	line, includes access stairway	
Rear:	4'	YES
STRUCTURE HEIGHT:	17' OR HEIGHT OF EXISTING SFR	YES

NOTICE TO ALL:

IT IS THE RESPONSIBILITY OF EACH AND EVERY CONTRACTOR, SUB-CONTRACTOR, AND/OR TRADE TO VERIFY ALL ASPECTS OF THESE DRAWINGS AND TO MAKE ANY AND ALL CORRECTIONS, ALTERATIONS, AND/OR CHANGES NECESSARY TO COMPLY WITH ALL CODE REQUIREMENTS, LOCAL REGULATIONS, AND PROPER DESIGN CRITERIA, UPON NOTIFICATION OF THE GENERAL CONTRACTOR AND DESIGNER AND TO ASSURE THE FUNCTION AND/OR OPERATION OF THE SAME, TO A REASONABLE STANDARD, AS REQUIRED BY LAW.

APPLICABLE CODES:

ALL CONSTRUCTION SHALL COMPLY WITH THE FOLLOWING CODES:

- 2015 INTERNATIONAL RESIDENTIAL CODE AS AMENDED BY THE
- STATE OF UTAH (IRC)
- 2018 INTERNATIONAL FIRE CODE (IFC)

DEFERRED SUBMITTALS:

DOCUMENTS FOR DEFERRED SUBMITTAL ITEMS SHALL BE SUBMITTED TO RANGE ARCHITECTURE AND DESIGN, WHO SHALL REVIEW AND FORWARD THEM TO THE BUILDING OFFICIAL WITH A NOTATION INDICIATION THAT THE DEFERRED SUBMITTAL DOCUMENTS HAVE BEEN REVIEWED AND HAVE BEEN FOUND TO BE IN GENERAL CONFORMANCE TO THE DESIGN OF THE PROJECT. THE DEFERRED SUBMITTAL ITEMS SHALL NOT BE INSTALLED UNTIL THE DESIGN AND SUBMITTED DOCUMENTS HAVE BEEN APPROVED BY THE BUILDING OFFICIAL.

THE FOLLOWING ARE DEFERRED SUBMITTAL ITEMS:

FIRE SPRINKLING SYSTEM

GENERAL NOTES - SITE PLAN

UTILITY LOCATIONS ARE SHOWN SCHEMATICALLY. CONTRACTOR TO VERIFY ALL UTILITY LOCATIONS PRIOR TO THE EXECUTION OF ANY WORK. WHEN SHOWN IN SITE PLAN. ALL DIMENSIONS ARE TO FACE OF FINISH TO

PROPERTY LINES, IMAGINARY LINES, SETBACKS, ETC., U.N.O. DO NOT SCALE DRAWINGS. WRITTEN DIMENSIONS GOVERN

SEE BUILDING PLANS FOR ALL OTHER NOTES AND DIMENSIONS NO SHOWN

NO PART OF RETAINING WALLS AND FOOTINGS SHALL ENCROACH INTO

ADJACENT PROPERTIES OR EASEMENTS THE PROPERTY OWNER SHALL MAINTAIN ALL DRAINAGE FACILITIES LOCATED WITHIN THE PARCEL AND BE RESPONSIBLE TO PREVENT DAMAGE TO DOWNSTREAM PROPERTIES.

CONTRACTOR IS TO CONTACT AND ABIDE BY THE RULES OF THE UTAH DIVISON OF AIR QUALITY, (801) 536-4000. F NO GAS UTILITY LINE OR METER ARE SHOWN ON THESE DRAWINGS THEN THERE IS NO GAS SERVICE PROVIDED TO THE SUBJECT PROPERTY.

ALL UTILITY TRENCHING MUST BE PER SLCPU STANDARD PRACTICE NO. ALL UTILITIES MUST MEET HORIZONTAL AND VERTICAL CLEARANCE REQUIREMENTS PER CODE. WATER & SEWER LINES REQUIRE 10' MIN. HORIZONTAL SEPARATION AND 18" MIN VERTICAL SEPARATION. SEWER MUST MAINTAIN 5' MIN. HORIZONTAL SEPARATION AND 12" VERTICAL SEPARATION FROM ANY NON-WATER UTILITIES. WATER MUST MAINTAIN 3' MINIMUM HORIZONTAL SEPARATION AND 12" VERTICAL SEPARATION FROM ANY NON-

SEWER UTILITES. A MINIMUM OF ONE EXTERIOR CLEANOUT IS REQUIRED ON THE SEWER LATERAL WITHIN 5' OF THE BUILDING. ADDITIONAL CLEANOUTS ARE REQUIRED AT EACH BEND AND AT LEAST ONE EVERY 50' FOR 4" LATERALS AND ONE EVERY 100' FOR 6" LATERALS.

SALT LAKE CITY PUBLIC UTILITIES GENERAL NOTES ARE INCORPORATED AS SEWER LATERAL MUST GRAVITY DRAIN ALL FLOORS AND MEET MINIMUM


SLOPE REQUIREMENTS (2% FOR 4" LATERALS, 1% FOR 6" LATERALS)" POWER COMPANY, GAS COMPANY AND COMMUNICATION COMPANIES ARE RESPONSIBLE FOR SUBMITTING DESIGN PLANS AS REQUIRED BY TITLE 14 CHAPTER 32 OF THE REVISED ORDINANCES OF SALT LAKE CITY FOR ALL PROPOSED WORK FOR THEIR RESPECTIVE UTILITY LINES FOR THIS PROJECT IN OR ADJACENT TO THE CITY ROW OR A PUBLIC UTILITIES ROW. PLAN REVIEWS ARE REQUIRED BY THE PUBLIC UTILITIES DEPT. UTILITY COORDINATOR AND HTE CITY ENGINEERING PUBLIC WAY PERMIT PLAN

ELECTRICAL SERVICE CONDUCTORS MUST BE A MINIMUM OF 8' ABOVE ANY

CONTRACTOR RESPONSIBILITIES

THE PROVIDED SITE PLAN IS DRAWN SCHEMATICALLY. IT IS THE SOLE RESPONSIBILITY OF THE GENERAL CONTRACTOR (GC) TO EXECUTE ANY/ALL REQUIRED SITE UTILITY & PREPARATION WORK IN ACCORDANCE WITH ALL APPLICABLE CODES & THE AUTHORITY HAVING JURISDICTION (AHJ). GENERALLY, THE GC SHALL BE RESPONSIBLE FOR THE COORDINATION, EXECUTION AND APPROVAL OF ALL WORK OUTSIDE OF THE MODULAR UNIT BUILDING ENVELOPE.

LEGEND - SITE PLAN

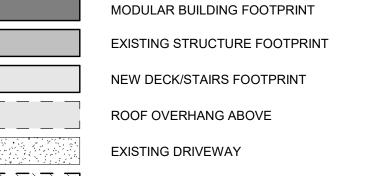

DEMOLISH EXISTING STRUCTURE/HARDSCAPE

SETBACK LINES FIRE HOSE PULL/HYDRANT DISTANCE

SEWER CLEAN-OUT. CLEANOUTS LOCATED ON DRIVE-WAY REQUIRE TRAFFIC RATED COVER.

APPROX. EXISTING SEWER LINE - CONTRATOR TO APPROX. NEW SEWER LINE - CONTRACTOR TO


FIELD LOCATE PER CODE. 4" SDR35 REQUIRED. APPROX. EXISTING WATER LINE - CONTRACTOR TO FIELD LOCATE PER CODE APPROX. NEW WATER LINE - CONTRACTOR TO

FIELD LOCATE PER CODE. 3/4" HDPE MIN. FIELD VERIFY SIZE TO MATCH EXISTING LATERAL FROM HOUSE TO METER. APPROX. EXISTING GAS LINE - CONTRACTOR TO

FIELD LOCATE PER CODE APPROX. EXISTING BURRIED ELECTRICAL/ TELECOMMUNICATIONS LINE - CONTRACTOR TO FIELD LOCATE PER CODE

APPROX. NEW ELECTRICAL/ TELECOMMUNICATIONS LINE - CONTRACTOR TO FIELD LOCATE - TRENCH & INSTALLATION SEPARATION PER UTILITY REQUIREMENTS & CODE

> AND REPAIR IF REQ'D PER S.L.O NEW UTILITY WORK IF REQ'D IN PUBLIC R.O.W.

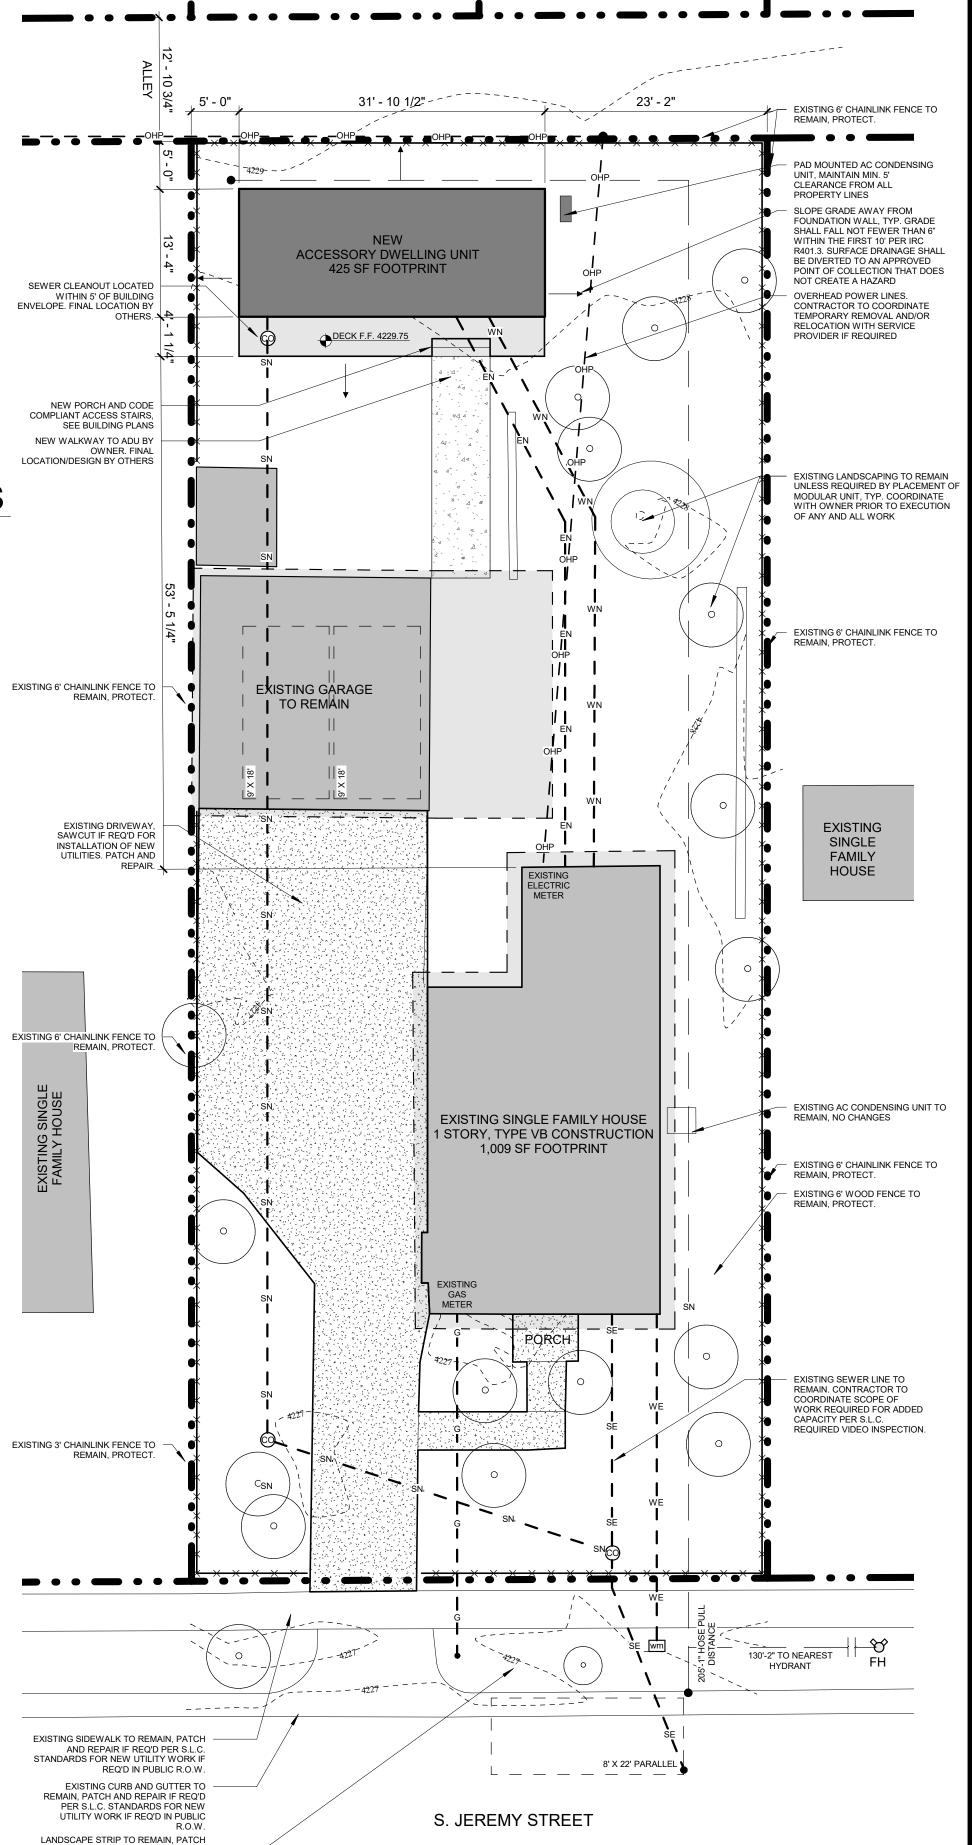



A # O St 0 2

EVISIONS 'ERMIT SET 05/14/2020 EVISION SETS OT DATE 05/14/2020 ROJECT 2033

RAWN BY IK HECKED BY N/A SHEET TITLE


TITLE SHEET, SITE


01 Site Plan
1" = 10'-0"


ABBRE'	VIATIONS
A.B. A.B.C. AC. Acoust. A.D. Add. Adj. A.F.F. AL. or Alum. Alt. & < Anod. Arch. Assy. BD. Btwn. B.O.F. Bldg. Blkg. BM. B.N. B.O. Bot. Brg.	Anchor Bolt Aggregate Base Course Air Conditioning Acoustical Access Door, Area Drain Addendum, Addition Adjustable Above Finish Floor Aluminum Alternate And Angle Anodized Architectural Assembly Board Between Bottom of Footing Building Blocking Beam Boundary Nail Bottom Bearing
B.Š. B.U. C.(or [) CBC Cer. C.B. CIP C.J. CL Clg. Clr. CMU Clos. C.O. Coon. Conc. Const. Cont. Coord. Corr.	Both Sides Built-up Channel California Building Code Ceramic Catch Basin Cast-in-place Control Joint Centerline Ceiling Clear(ance) Concrete Masonry Unit Closet Clean-out Column Composite Concrete Construction Continuous Coordinate Corridor
Ctr. d D.P. DBA. D.F. Dbl. Dia. Diag. Diaph. Dim. D.L. DN DR. D.S. Dtl. Dwg. Dwls.	Penney (nail size) Damp Proofing Dark Bronze Anodized Douglas Fir Double Diameter Diagonal Diaphragm Dimension Dead Load Down Door Downspout Detail Drawing Dowels
E. EA. E.B. E.J. Elec. Elev. E.N. Encl. EQ. Equip. E.W. Ext. Exist.	East Each Expansion Bolt Expansion Joint Electric(al) Elevation Edge Nail Enclosure Equal Equipment Each Way Exterior Existing
FACP F.B. F.D. Fdn. F.E.C. F.F. F.F.E. F.G. F.H.(M.)S. Fin. Flr. Fluor. F.M.C. F.N. F.O. F.O.B. F.O.B. F.O.C. F.O.P. F.O.P. F.O.S. FT. Ftg. F.S.	Fire Access Control Panel Flat Bar Floor Drain Foundation Fire Extinguisher Cabinet Finish Floor, Factory Finisi Finished Floor Elevation Finished Grade, Pultruded Fiberglass Fire Hose Cabinet Flat Head Screw Finish Floor Fluorescent Floor Material Change Field Nailing Face of (specify item) Face of Brick Face of Concrete Face of Finish Face of Masonry Face of Panel Face of Stud Foot, Feet Footing Finish Surface, Floor Sink
GA. Galv. G.I. GL. GL.B. GWB H.B. HC. HCMB. HD. Hdr. Hdwr. Hgr. Horiz. HR. HM. H.S.S. HT. HVAC H.W.	Gauge Galvanized Galvanized Iron Glass Glu-lam beam Gypsum Wall Board Hose bibb Hollow Core Honeycomb Core Head Header Hardware Hanger Horizontal Hour Hollow Metal Hollow Structural Section Height Heating, Ventilation and Air Conditioning Hot Water

A.B.	Anchor Bolt	Jan.	Janitor
A.B.C.	Aggregate Base Course	Jst.	Joist
AC.	Air Conditioning	JT.	Joint
Acoust. A.D.	Acoustical Access Door, Area Drain	Kit.	Kitchen
Add.	Addendum, Addition Adjustable	K.J.	Keyed Joint
Adj.		K.O.	Knock Out
A.F.F. AL. or Alum.	Above Finish Floor Aluminum	Lam.	Laminated
Alt.	Alternate	Lav.	Lavatory
	And	L.B.	Lag Bolt
<	Angle	L.L.	Live Load
Anod.	Anodized	L.L.H.	Long Leg Horizontal
Arch.	Architectural	L.L.V.	Long Leg Vertical Longitudinal
Assy.	Assembly	Longit.	
BD.	Board	L.P. L.W.C.	Low Point Light Weight Concrete
Btwn. B.O.F.	Between Bottom of Footing	Mas.	Masonry
Bldg.	Building	MDF.	Medium Density Fiberboard Medium Density Fiberboard-Outdo
Blkg.	Blocking	M.D.O.	
BM.	Beam	M.O.	Masonry Opening Material
B.N.	Boundary Nail	Matl.	
B.O.	Bottom of	Max.	Maximum
Bot.	Bottom	Mech.	Mechanical
Brg.	Bearing	Memb.	Membrane
B.S.	Both Sides	Mtl.	Metal
B.U.	Built-up	Mfr. Min.	Manufacturer Minimum
C.(or [) CBC	Channel California Building Code	Misc.	Miscellaneous
Cer.	Ceramic	N.	North
C.B.	Catch Basin	N.A.	Not Applicable
CIP	Cast-in-place	N.I.C.	Not in Contract Not to Scale
C.J.	Control Joint	N.T.S.	
CL Clg.	Centerline Ceiling	NO.	Number
Clr.	Clear(ance) Concrete Masonry Unit	O.C.	On Center
CMU		O.D.	Outside Diameter
Clos. C.O.	Closet Clean-out	0.F. 0.F.C.I.	Overflow, Outside Face Owner Furnished/Contractor Instal
Col. Comp.	Column	O.H. Opng.	Opposite Hand Opening
Conc.	Composite Concrete	Opng. Opp.	Opposite
Const.	Construction Continuous	PL.	Plate Perimeter
Coord.	Coordinate	Perim.	Perpendicular
Corr.	Corridor	Perp.	
Ctr.	Center	P.Lam. Plas.	Plastic Laminate Plaster
d	Penney (nail size) Damp Proofing	Plast.	Plastic
D.P.		P.D.	Planter Drain
DBA.	Dark Bronze Anodized Douglas Fir	P.L.F.	Per Lineal Foot
D.F.		Plywd.	Plywood
Dbl.	Double	P.S.F.	Pounds Per Square Foot Pounds Per Square Inch
Dia.	Diameter	P.S.I.	
Diag.	Diagonal	P.T.	Pressure Treated, Post-tensioned Post-tensioned Slab
Diaph.	Diaphragm	P.T.S.	
Dim.	Dimension	PV	Photovoltaic
D.L.	Dead Load	PVC	Polyvinyl Chloride
DN DR.	Down Door	R.C.P.	Reflected Ceiling Plan
D.S.	Downspout	R.D.	Roof Drain
Dtl.	Detail	Ref.	Refer(ence)
Dwg.	Drawing	Reinf.	Reinforcing
Dwls.	Dowels	Reqd.	Required
E.	East	Rqmt. Resil.	Requirements Resilient
EA.	Each	Ret.	Retain(ing)
E.B.	Expansion Bolt	RM.	Room
E.J. Elec.	Expansion Joint Electric(al)	R.O.	Rough Opening
Elev.	Elevation	S.	South
E.N.	Edge Nail	SC.	Scale, Screw, Solid Core
Encl.	Enclosure	Sched.	Schedule
EQ.	Equal	SF.	Square Feet
Equip.	Equipment	Sht.	Sheet
E.W.	Each Way	Sim.	Similar
Ext.	Exterior	SH.	Single Hung
Exist.	Existing	Sldr.	Slider
FACP	Fire Access Control Panel	S.M.F.E. Spec.	Surface-mounted Fire Extinguisher Specification
F.B.	Flat Bar	SQ.	Square
F.D.	Floor Drain	S.S.	Stainless Steel
Fdn.	Foundation Fire Extinguisher Cabinet	Stagg.	Staggered
F.E.C.		Std.	Standard
F.F.	Finish Floor, Factory Finish Finished Floor Elevation	Stiff.	Stiffener
F.F.E.		Stor.	Storage, Storefront
F.G.	Finished Grade,	Str.	Structural
	Pultruded Fiberglass	Stl.	Steel
F.H.C. F.H.(M.)S.	Fire Hose Cabinet Flat Head Screw	Sym.	Symmetrical
Fin. '	Finish	T.	Tread, Tempered
	Floor	T&G	Tongue and Groove
Fluor.	Fluorescent	Thr.	Threshold Tenant Improvement
F.M.C.	Floor Material Change	T.I.	
F.N.	Field Nailing Face of (specify item)	T.J.	Tooled Joint
F.O.		T.N.	Toe Nailed
F.O.B. F.O.C.	Face of Concrete	T.O. T.O.C.	Top of (specify item) Top of Curb
F.O.F. F.O.M.	Face of Finish Face of Masonry	T.O.G. T.O.P.	Top of Grate Top of Plate
F.O.P. F.O.S.	Face of Museriny Face of Panel Face of Stud	T.O.S. T.O.W.	Top of Viale Top of Sheathing Top of Wall
FT.	Foot, Feet	Trans.	Transverse
Ftg.	Footing	Typ.	Typical
F.S.	Finish Surface, Floor Sink	U.N.O.	Unless Noted Otherwise
GA.	Gauge	U.L.	Underwriters Laboratory
Galv.	Galvanized	URM	
Galv. G.I. GL.	Galvanized Galvanized Iron Glass	Vent.	Unreinforced Masonry
G.L.B. GWB	Glu-lam beam	Vert.	Ventilator, Ventilation Vertical
	Gypsum Wall Board	V.R. V.T.R.	Vapor Retarder Vent Through Roof
H.B.	Hose bibb	V.T.W.	Vent Through Wall Vinyl Vinyl Covering
HC.	Hollow Core	VN.	
HCMB.	Honeycomb Core	V.W.C.	Vinyl Wall Covering Vinyl Chain Link
HD.	Head	V.C.L.	
Hdr. Hdwr.	Header Hardware	V.C.T.	Vinyl Composition Tile
Hgr.	Hanger	W.	West
Horiz.	Horizontal	Wdw.	Window
HR.	Hour	W/	With
HM.	Hollow Metal	W.GL.	Wire Glass
H.S.S.	Hollow Structural Section	W.H.	Water Heater
HT.	Height	W/O	Without
HVAC	Heating, Ventilation and	WP.	Waterproof
	Air Conditioning	W.P.J.	Weakened Plane Joint
H.W.	Hot Water	W.R. WT.	Water Resistant Weight
I.D.	Inside Diameter	W.W.F.	Welded Wire Fabric
IN.	Inch	W.W.M.	Welded Wire Mesh
Incl.	Included	WD.	Wood
Insul.	Insulation		

LEGEND - PROJECT SYMBOLS ? Keynote Window/Storefront Tag

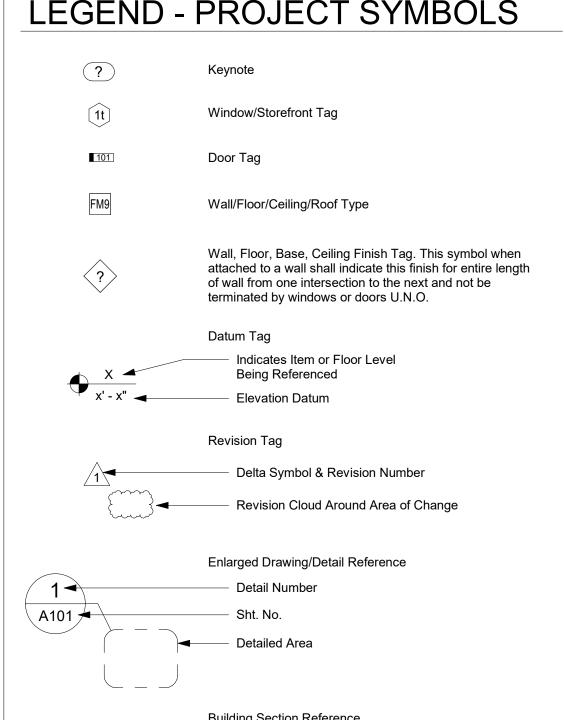

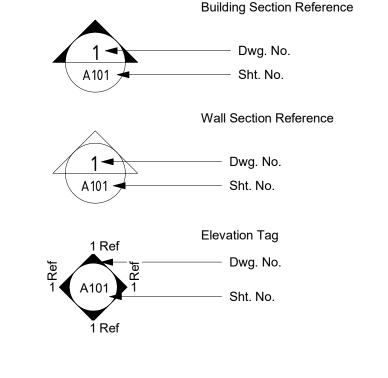

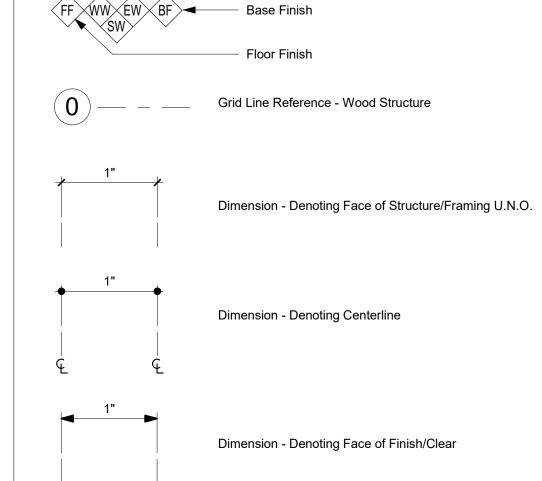

Finish Tag

Corresponding Wall Finishes



GENERAL RESIDENTIAL NOTES


- It is the responsibility of the contractor to become fully aware of any and all conditions related to the site and existing conditions that may effect the cost of scheduling construction activities, prior to submitting a bid.
- Contractor shall be responsible for verifying all dimensions and conditions at the job site including soil conditions, and other conditions related to the existing utilities and services prior to commencing work.
- Do not scale drawings or details use given dimensions. Check details for location of all items not dimensioned on plans. Dimensions on plans are to face of framing, exterior face of foundation, or centerline of columns, unless noted otherwise.
- Doors and cased openings without dimensions are to be four and one half (4-1/2) inches from face of adjacent wall or centered between walls. The drawings indicate general and typical details of construction. Where conditions are not specifically indicated but are of similar character to details shown, similar details of construction shall be used, subject to review and approval by the architect and structural
- Building systems and components not specifically detailed shall be installed, as per minimum manufacturer recommendations. Contractor shall notify the architect of any
- resulting conflicts prior to commencing work. All work shall conform to applicable building codes and ordinances. In case of any conflict wherein the methods or standards of installation or the materials specified do not equal or exceed the requirements of the laws or ordinances, the laws or ordinances shall govern. Consulting engineer(s) drawings are supplementary to the architectural drawings. It shall be in the responsibility of each contractor to check with the architectural drawings before installation of their work. Any discrepancy between the archtitectural drawings and the
- and owner's attention in writing. Any dimensions, tags or details not shown shall be requested by the contractor to the architect. This project contains glazing that will be subject to federal and local glazing standards and the glazing subcontractor shall be responsible for adherance to these requirements. If the

consulting engineer(s) or other supplementary drawings shall be brought to the architect

- glazing subcontractor finds discrepancies in the documents not in compliance with the standards, he/she shall bring discrepancies to the attention of the architect before All glazing in hazardous locations, defined by IRC R308.4, shall be safety glazing, including
- but not limited to the safety glazing identified in the construction documents. Install dust barriers and other protection as reqruired to protect installed finishes and
- There shall be no exposed pipe, conduits, ducts, vents, etc. All such lines shall be concealed or furred and finished, unless noted as exposed construction on drawings. Offset
- studs where required, so that finished wall surface will be flush. Contractor shall provide temporary bracing for the structure and structural components until all final connections have been completed in accordance with the plans. Carry all footings to solid, undisturbed original earth. Removal all suitable material under
- footings and slab and replace with concrete or compacted fill as directed by engineer and architect. All wood framing details not shown otherwise shall be constructed to the minimum
- standards of the IRC. All wood in direct contact with concrete or exposed to weather shall be pressure treated with an approved preservative unless decay resistant heartwood of cedar or redwood is used. Fasteners for pressure treated wood shall be hot dipped galvanized steel, stainless steel, silicon bronze, or copper.
- Nail gypsum wallboard to all studs, top and bottom plates and blocking with cooler nails @ 7" o.c. maximum spacing unless shown otherwise. Use 5d for 1/2" wallboard, 6d for 5/8" wallboard.
- Provide galvanic insulation between dissimilar metals. The contractor is to verify the location of all utilities and services to the site prior to beginning any site improvements.
- No materials from the work are to be stock piled on public right-of-ways. All rubbish and debris is to be removed from the site.
- Adjacent properties, streets and walks are to be protected from damage at all times. The contractor shall secure permits required by the fire department prior to building
- The contractor shall take all necessary precautions to ensure the safety of the occupants and workers at all times during the course of the project. Approved plans shall be kept in a plan box and shall not be used by any workmen. All
- construction sets shall reflect the same information. The contractor shall also maintain in good condition, one complete set of plans with all revisions, addenda and change orders on the premises at all times. Said plans are to be under the care of the job superintendent.
- The contractor and/or the sub-contractors shall apply for, obtain, and pay for all required permits and fees except for the building permit.
- Construction hours, per jurisdiction, are to be observed for all phases of the project. Class "A" roofing is required for fire protection. Remove all vegetation, organic material and wood formwork from under-floor grade before
- the building is occupied for any reason. Fireblocking shall be provided to cut off all concealed draft openings (both vertical & horizontal) and to form an effective fire barrier between stories, and between a top story and the roof space, including the following: vertically at ceiling and floor levels, horizontally at intervals not exceeding 10 feet, at all interconnections between concealed vertical & horizontal spaces such as soffits, drop and cove ceilings, in concealed spaces between stair stringers at the top and bottom of the run, and at openings around vents, pipes, and ducts at ceiling and floor level with an approved material to resist the free passage of flame.
- Wall covering products sensitive to adverse weather shall not be installed until adequate weather protection for the installation is provided. Exterior sheathing shall be dry before Interior coverings or wall finishes shall be installed in accordance with IRC chapter 7 and tables R702.1(1), R702.1(2), R702.1(3) and R702.3.5. Interior masonry veneer shall comply
- with the requirements of R703.7.1 for support and section R703.7.4 for anchorage, except an air space is not required. Interior finishes and materials shall conform to the flame spread and smoke density requirements of R302.9.
- Unless specified otherwise, all coverings shall be fastened in accordance with table R703.3 or with other approved aluminum, stainless steel, zinc-coated or other corrosion-resistive
- Installation of appliances shall conform to the conditions of their listing and label and manufacturer's installation instructions. The manufacturer's operating and installation instructions shall remain attached to the appliance. A permanent factory-applied nameplate shall be affixed to appliances on which shall
- appear, in legible lettering, the manufacturers name or trademark, the model number, serial number, and the seal or mark of the testing agency. The hourly rate in btu/h(w), type of fuel or electrical rating and other information as described in IRC M1303.1 and G2404.3 shall be required on the label.
- Where conflicts occur between the IRC and the conditions of listing or the manufacturer's installation instructions occur, the provisions of the code shall apply. Fuel-fired appliances shall be designed for use with the type of fuel to which they will be connected and the altitude at which they are installed. Appliances that comprise parts of the
- building mechanical system shall not be converted. The fuel input rate shall not be increased or decreased beyond the limit rating for the altitude at which the appliance is The building or structure shall not be weakened by the installation of mechanical systems.
- Where floors, walls, ceilings or any other portion of the building or structure are required to be altered or replaced in the process of installing or repairing any system, the building or structure shall be left in a safe structural condition in accordance with the IRC. Heat-producing equipment and appliances shall be installed to maintain the required clearances to combustible construction as specificed in the listing and manufacturer's instructions. Reduction of clearances shall be in accordance with manufacturer's instructions and IRC table M1306.2 or IMC section 308. Clearances to combustibles shall include such considerations as door swing, shutters, coverings and drapes. Devices such as door stops or limits, closers, drapery ties or guards shall not be used to provide

adequate clearances.




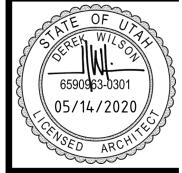

ERMIT SET 05/14/2020 REVISION SETS PLOT DATE 05/14/2020 PROJECT DRAWN BY 1K CHECKED BY N/A

> ABBREVIATIONS, SYMBOLS, GENERAL


SHEET TITLE

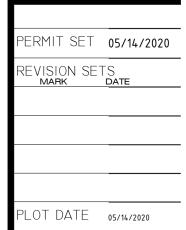


PROJECT DRAWN BY 1K


CHECKED BY N/A SHEET TITLE

ASSEMBLIES

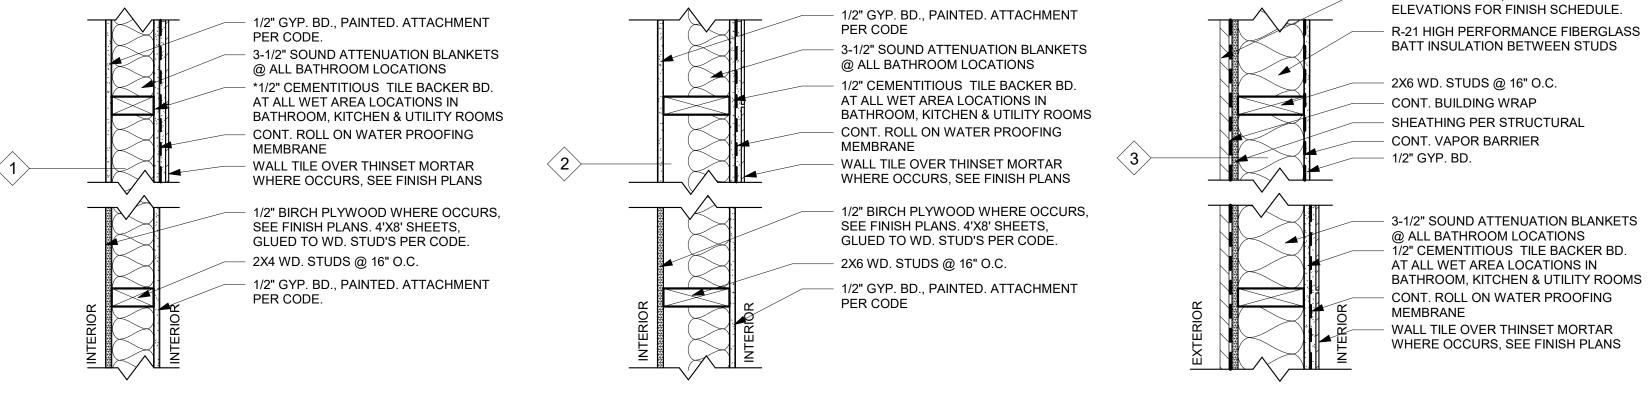


LEGEND - WALL TYPES

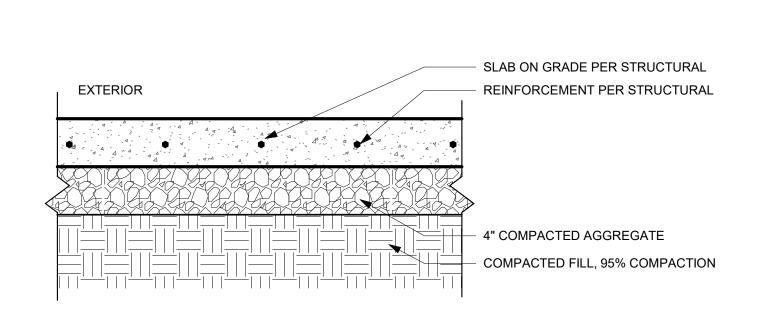


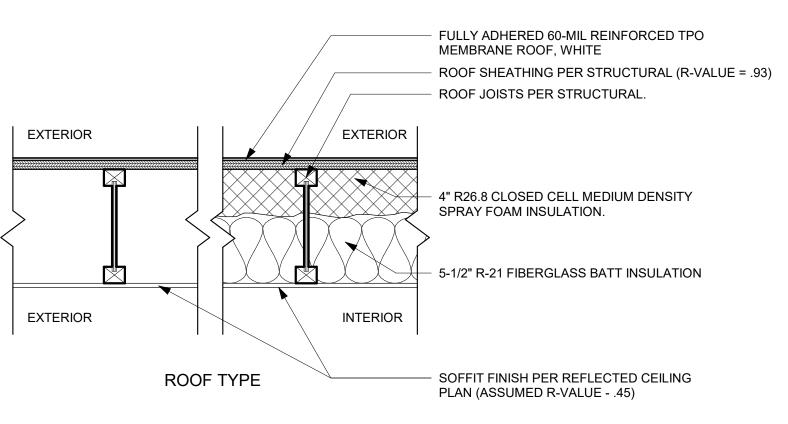

EXTERIOR FINISH, SEE EXTERIOR

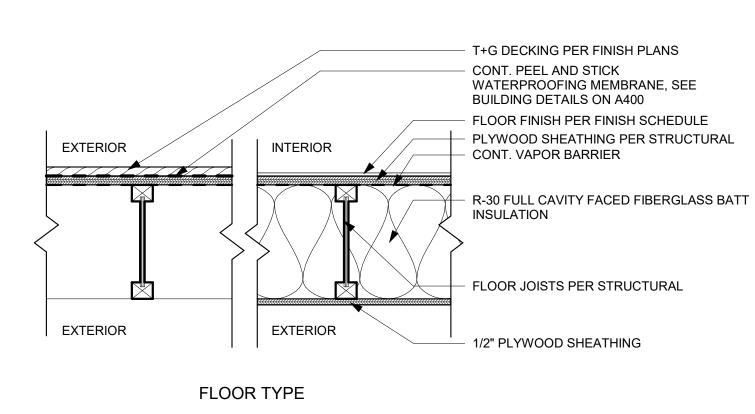

LEGEND - FLOOR & ROOF TYPES

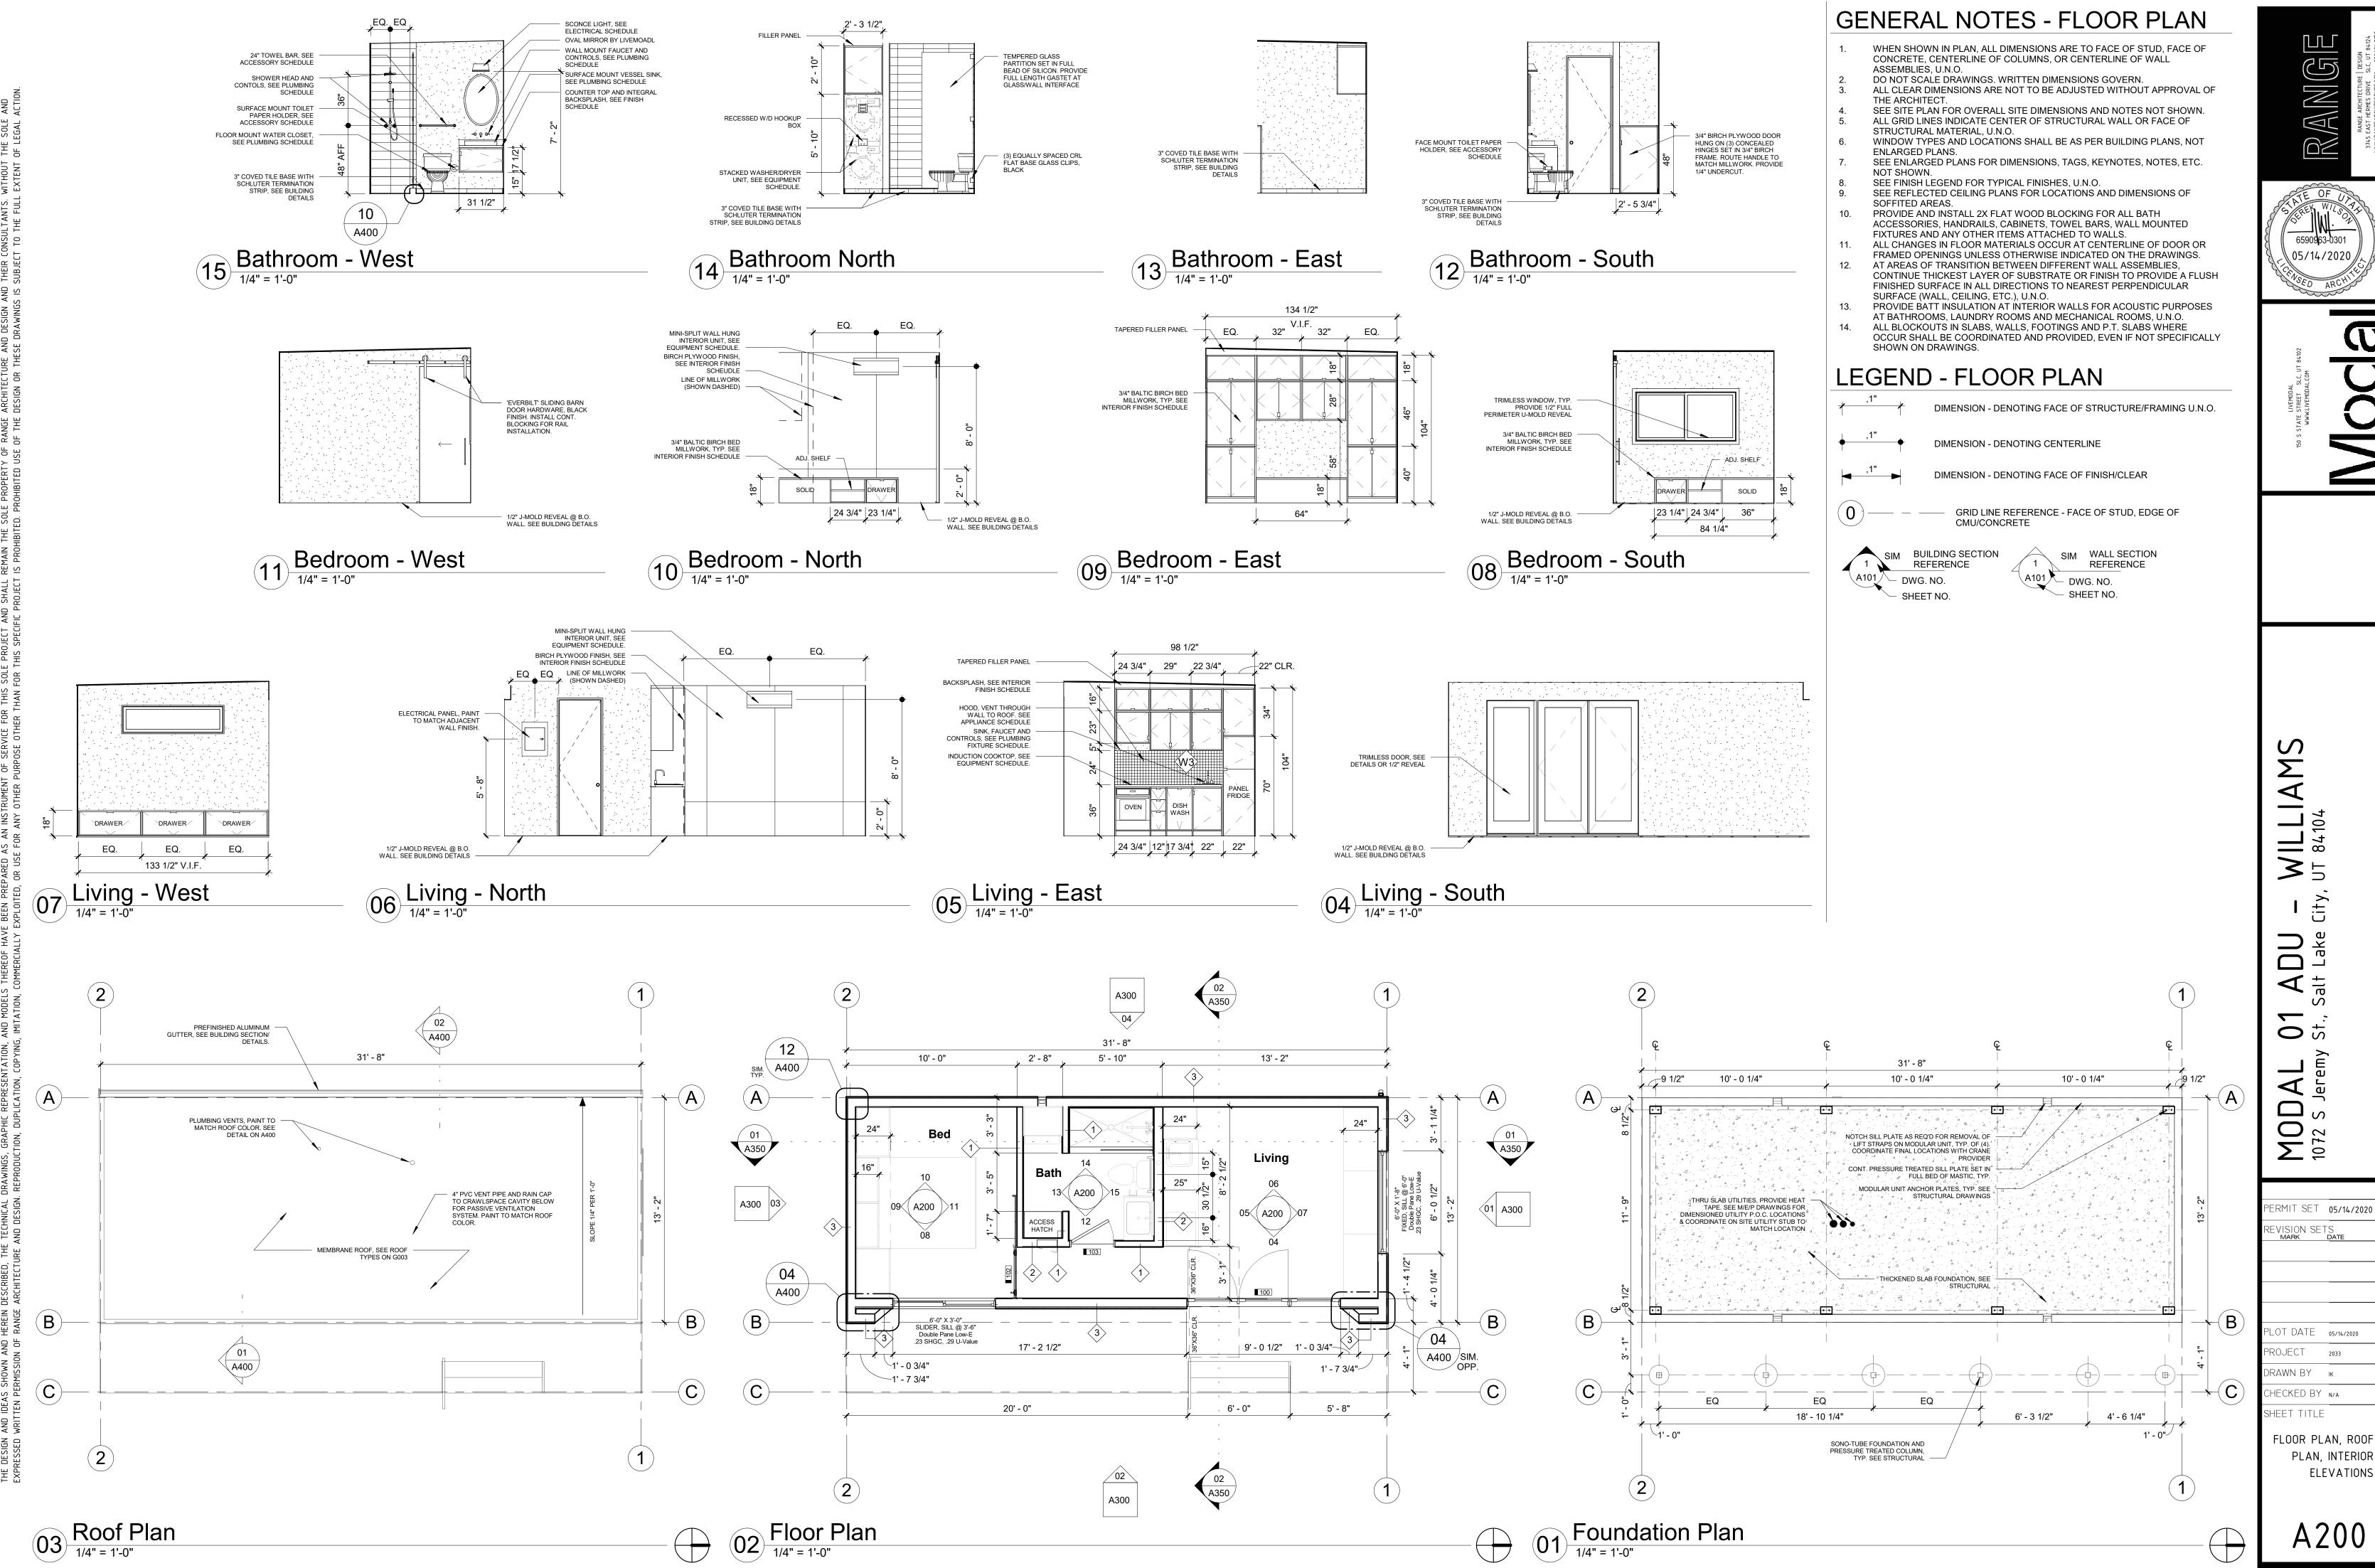

Lake O St. MOD 1072 S J

> ERMIT SET 05/14/2020 REVISION SETS mark date

HECKED BY N/A FLOOR PLAN, ROOF PLAN, INTERIOR

A200

GENERAL NOTES - RCP

DIMENSIONS OF SOFFITED AREAS.

ACCESS PANELS AND GRILLE SIZES.

GYP. BD. CEILING

VANITY LIGHT

90 CFM EXHAUST FAN

ENLARGED PLANS.

LEGEND - RCP

⊕ WP

ALL DIMENSIONS TO FACE OF STRUCTURAL MATERIAL, U.N.O. ALL GRID LINES INDICATE CENTER OF STRUCTURAL WALL OR FACE OF

FOR ALL DOOR, WINDOW & WALL TYPES REFER TO FLOOR PLANS AND

REFER TO MECHANICAL DRAWINGS FOR ADDITIONAL INFORMATION ON

PROVIDE CONCEALED PENDANT TYPE SPRINKLER HEADS AT ALL UNIT

3" CEDAR, SEE EXTERIOR FINISH SCHEDULE

4" RECESSED LED DOWNLIGHT, MATT BLACK.

WATER PROOFED WHERE INDICATED

1/2" BIRCH PLYWOOD, SEE INTERIOR FINISH SCHEDULE

EXTERIOR CUSTOM LIGHT, SEE EXTERIOR ELEVATIONS

HARDWIRED COMBINATION SMOKE & CO SENSOR

SUBCONTRACTOR TO VERIFY ALL DIMENSIONS PRIOR TO CONSTRUCTION


STRUCTURAL MATERIAL, U.N.O. WRITTEN DIMENSIONS TO PREVAIL OVER SCALING OF DRAWINGS.

AND IMMEDIATELY NOTIFY ARCHITECT OF ANY DISCREPANCIES. REFER TO FRAMING PLANS AND SECTIONS FOR CLARIFICATION AND

FINISH & REFLECTING CEILING PLANS, SCHEDULES

A201

MARK	MATERIAL	MANUFACTURER	COLOR / MODEL #
FLOOR			
F1	LINOLEUM	FORBO	MARMOLEUM - CONCRETE
F2	TILE	TBD	WHITE
F3	TILE - ACCENT	TBD	WHITE
F4	EXTERIOR DECKING	TREX	COLOR TO MATCH EXTERIOR SIDING
BASE			
B1	3" COVED TILE	TBD	WHITE
B2	1/2" GYP. BD. REVEAL	TBD	TBD
WALLS			
W1	GYP. BD PAINTED	TBD	TBD
W2	TILE	TBD	WHITE
W3	TILE - ACCENT	TBD	WHITE
W4	NOT USED	N/A	N/A

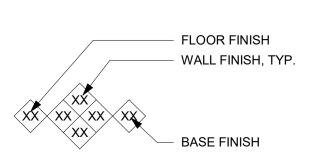

QUARTZ TBD WHITE TBD N/A N/A CLEAR COAT SEALANT BIRCH PLYWOOD - SEALED NOT USED

CLEAR COAT

CLEAR COAT

TBD

INTERIOR FINISH SCHEDULE & LEGEND

TBD

TBD

1/2" BIRCH PLYWOOD

GYPBOARD - PAINTED

1/2" BIRCH PLYWOOD

CEILINGS/SOFFITS

C1


C2

COUNTERS

CT1


CT2


MILLWORK

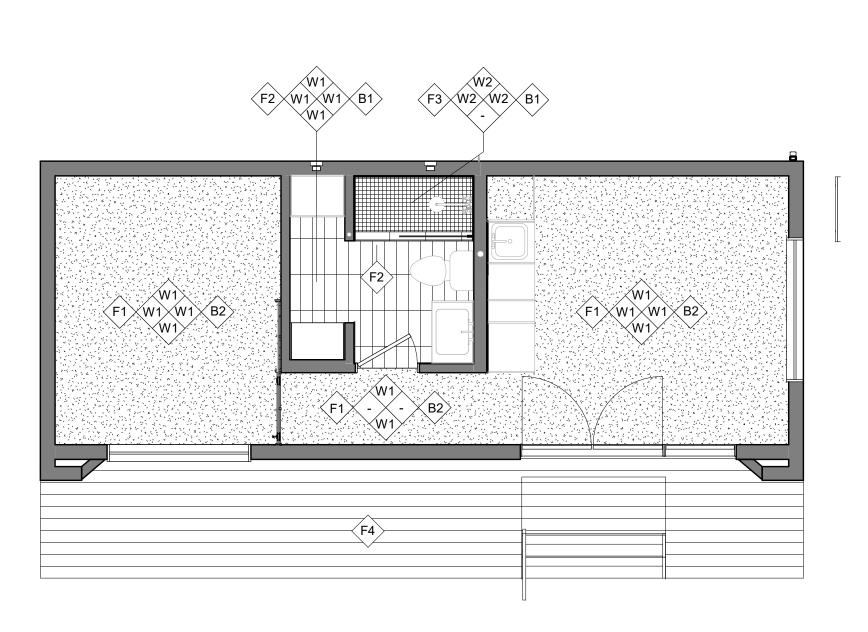


Finish Plan & Schedule

1/4" = 1'-0"

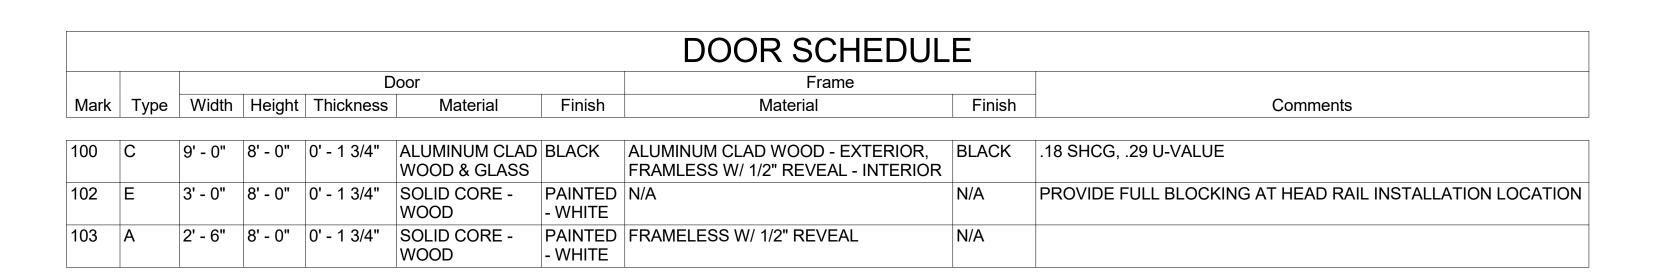

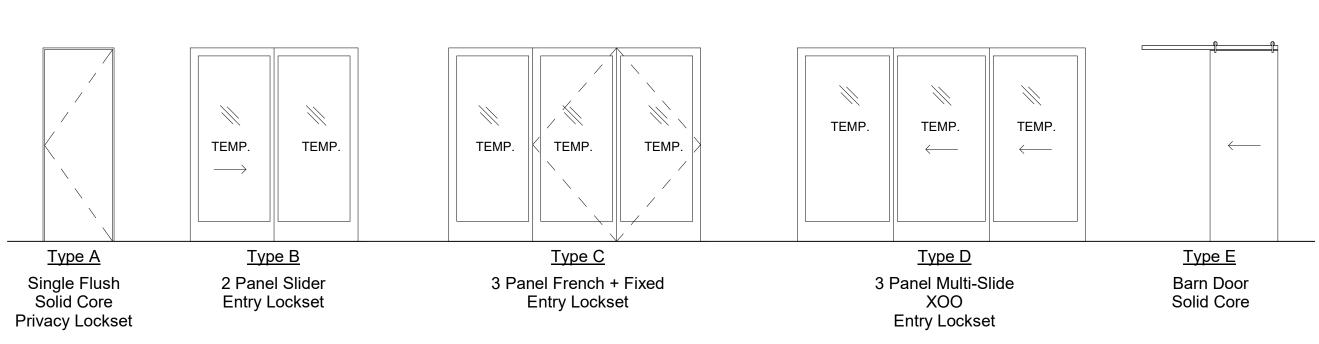

DOOR LEGEND

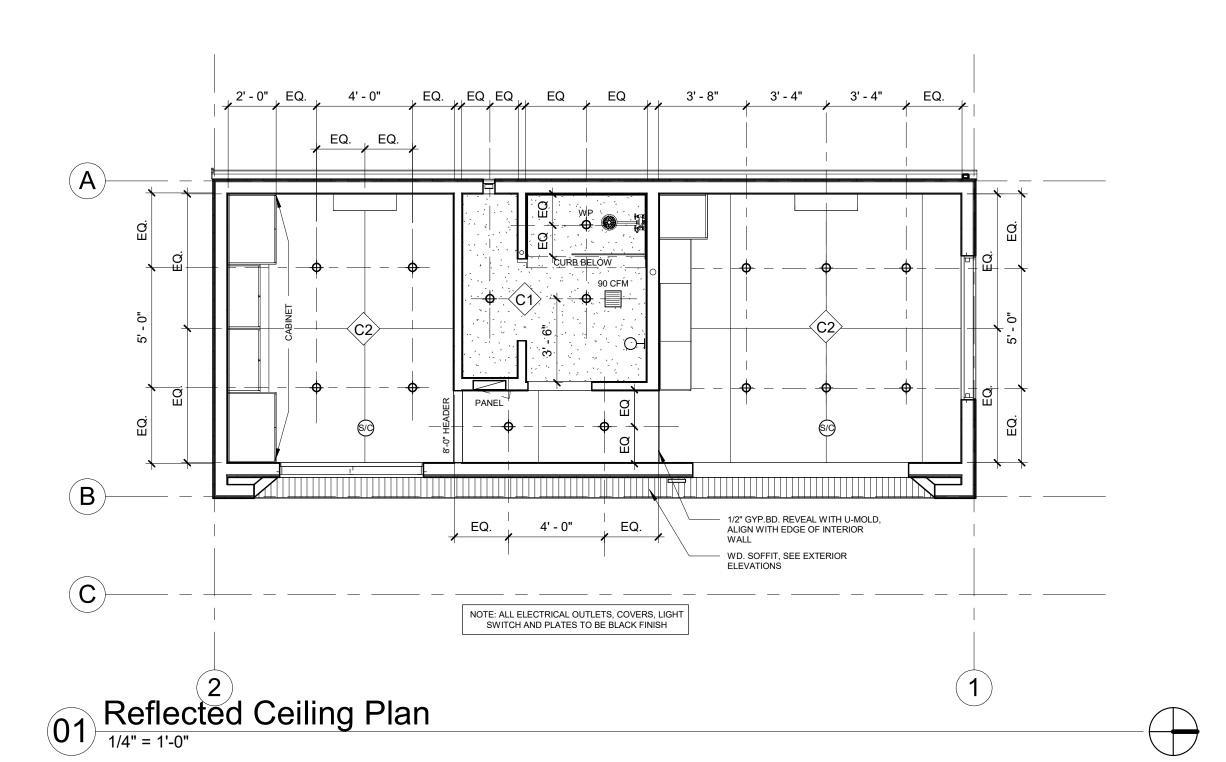

MARK

NOT USED NOT USED

CEMENT BOARD

STEEL HANDRAIL

STAIR RISER

PREFINISHED MTL. DOWNSPOUT — & GUTTER, PAINT TO MATCH ADJACENT EXTERIOR SIDING

DOWNSPOUT ELBOW AND 24"


MTL. ROOF FLASHING

VERTICAL CEDAR SIDING - 3"


HORIZONTAL CEDAR SIDING - 3"

PLASTERED FOUNDATION WALL


ALUM. GUTTER AND DOWNSPOUT

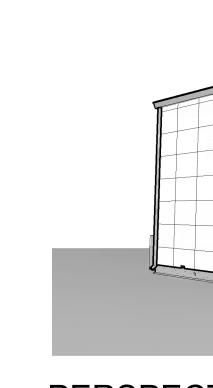



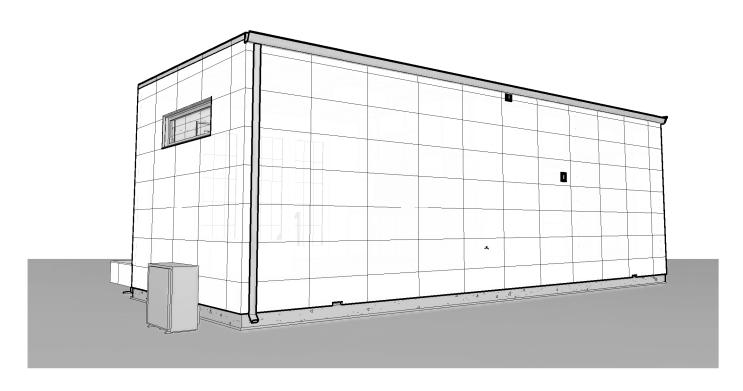

PERSPECTIVE 3

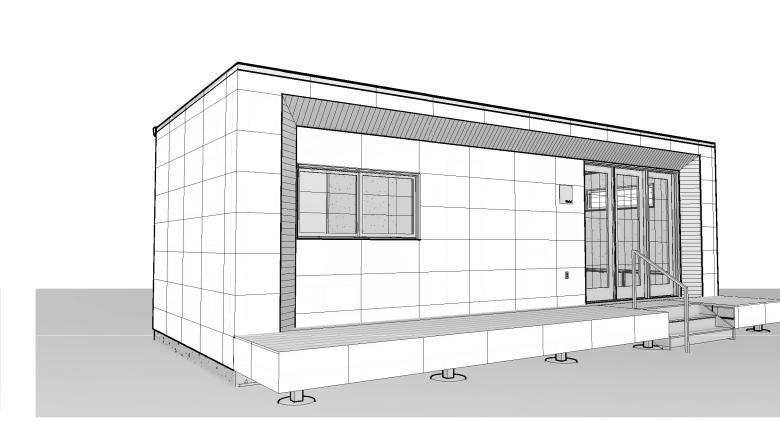

EXTERIOR FINISH SCHEDULE

MANUFACTURER

N/A

TBD

TBD

TBD

TBD

COLOR / MODEL #

WHITE

BLACK

BLACK

STAINED - CLEAR COAT STAINED - CLEAR COAT

POWDERCOAT BLACK


STAIN TO MATCH DECK FINISH

COLOR TO MATCH EXTERIOR SIDING

PERSPECTIVE 2

PERSPECTIVE 1

B

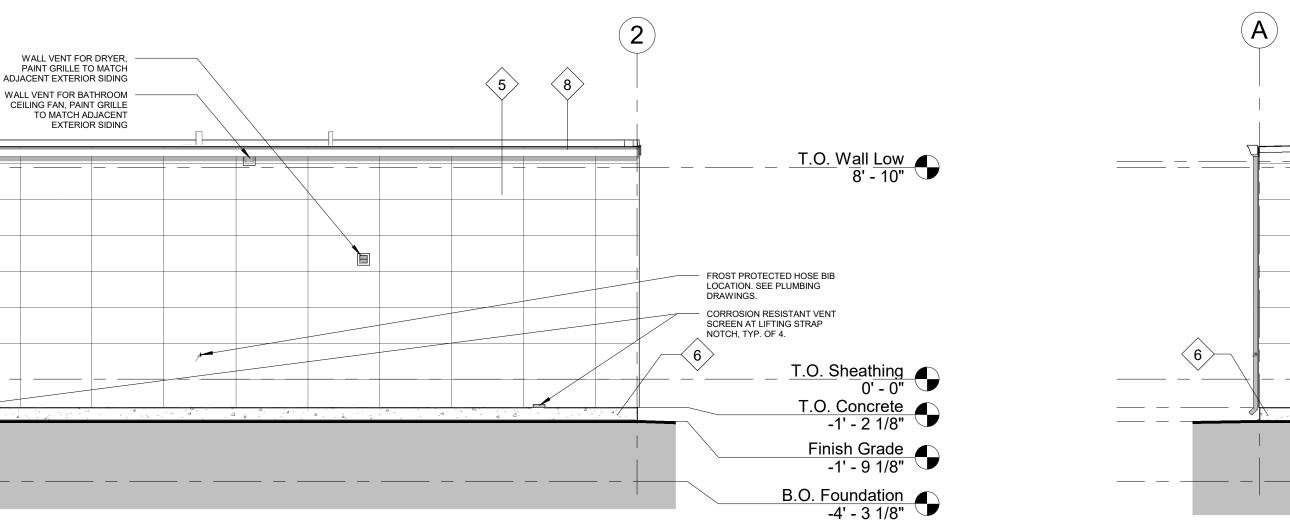



WEST ELEVATION 1/4" = 1'-0"


02 EAST ELEVATION

1/4" = 1'-0"

8

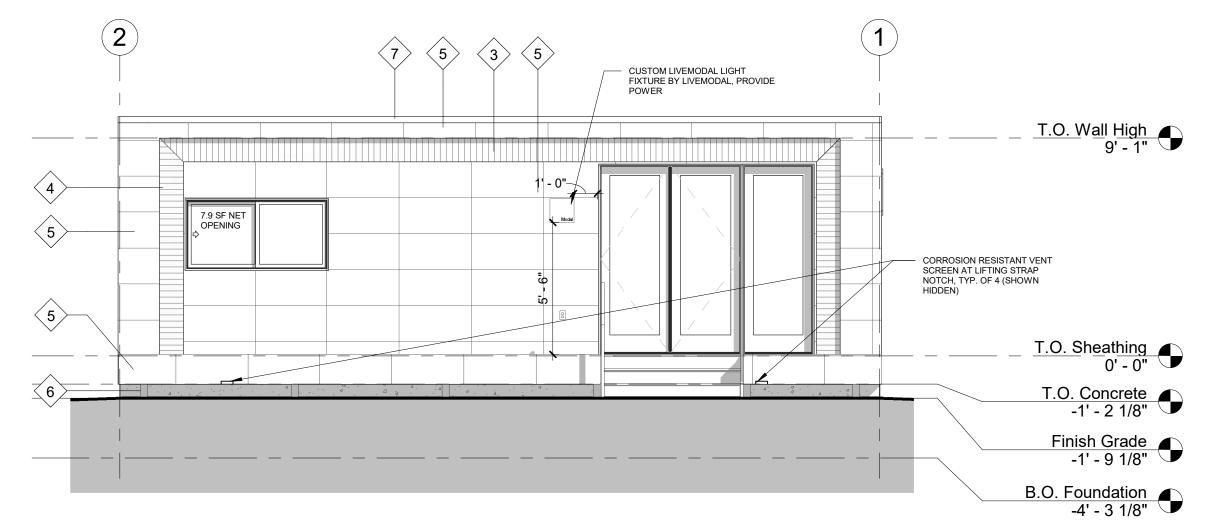

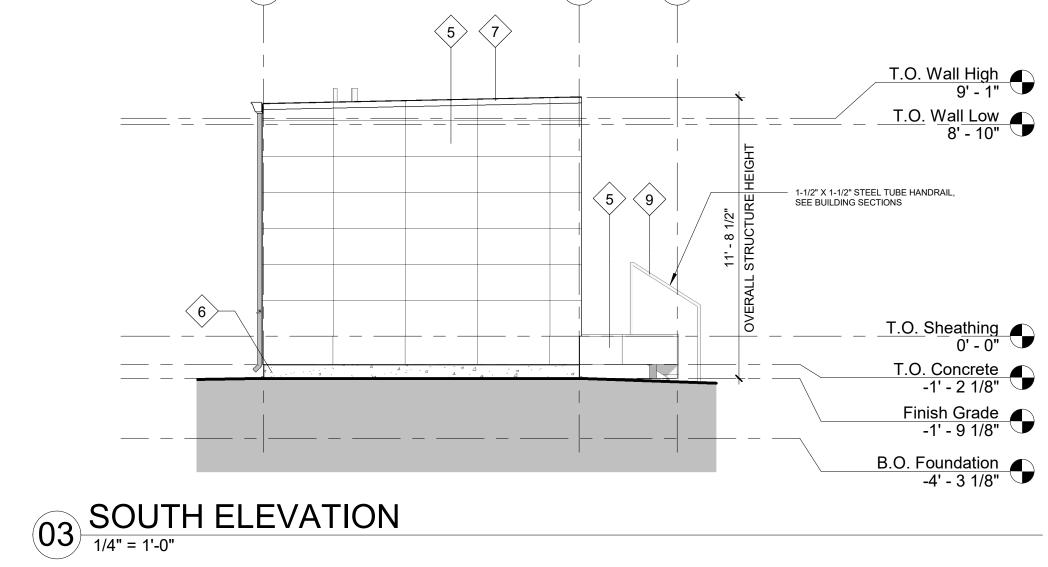

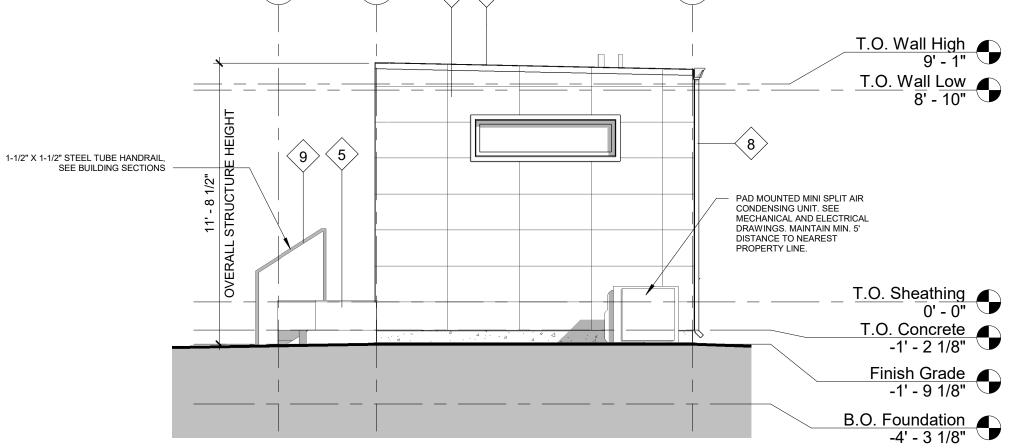


01 NORTH ELEVATION 1/4" = 1'-0"

GENERAL NOTES - ELEVATIONS

- WHEN SHOWN IN ELEVATION OR SECTION, ALL DIMENSIONS ARE TO TOP OF PLATE, TOP OF CONCRETE OR TOP OF CEMENT-BASED UNDERLAYMENT, U.N.O.
 DO NOT SCALE DRAWINGS, WRITTEN DIMESNSIONS GOVERN.
 ALL CLEAR DIMENSIONS ARE NOT TO BE ADJUSTED WITHOUT APPROVAL OF THE ARCHITECT.



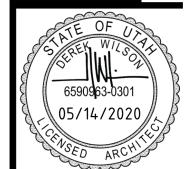

ADU Salt Lake O St.)AL Jerem


PERMIT SET 05/14/2020 REVISION SETS MARK DATE DRAWN BY 1K

MOD 1072 S J

CHECKED BY N/A SHEET TITLE

BUILDING ELEVATIONS & 3D

A300

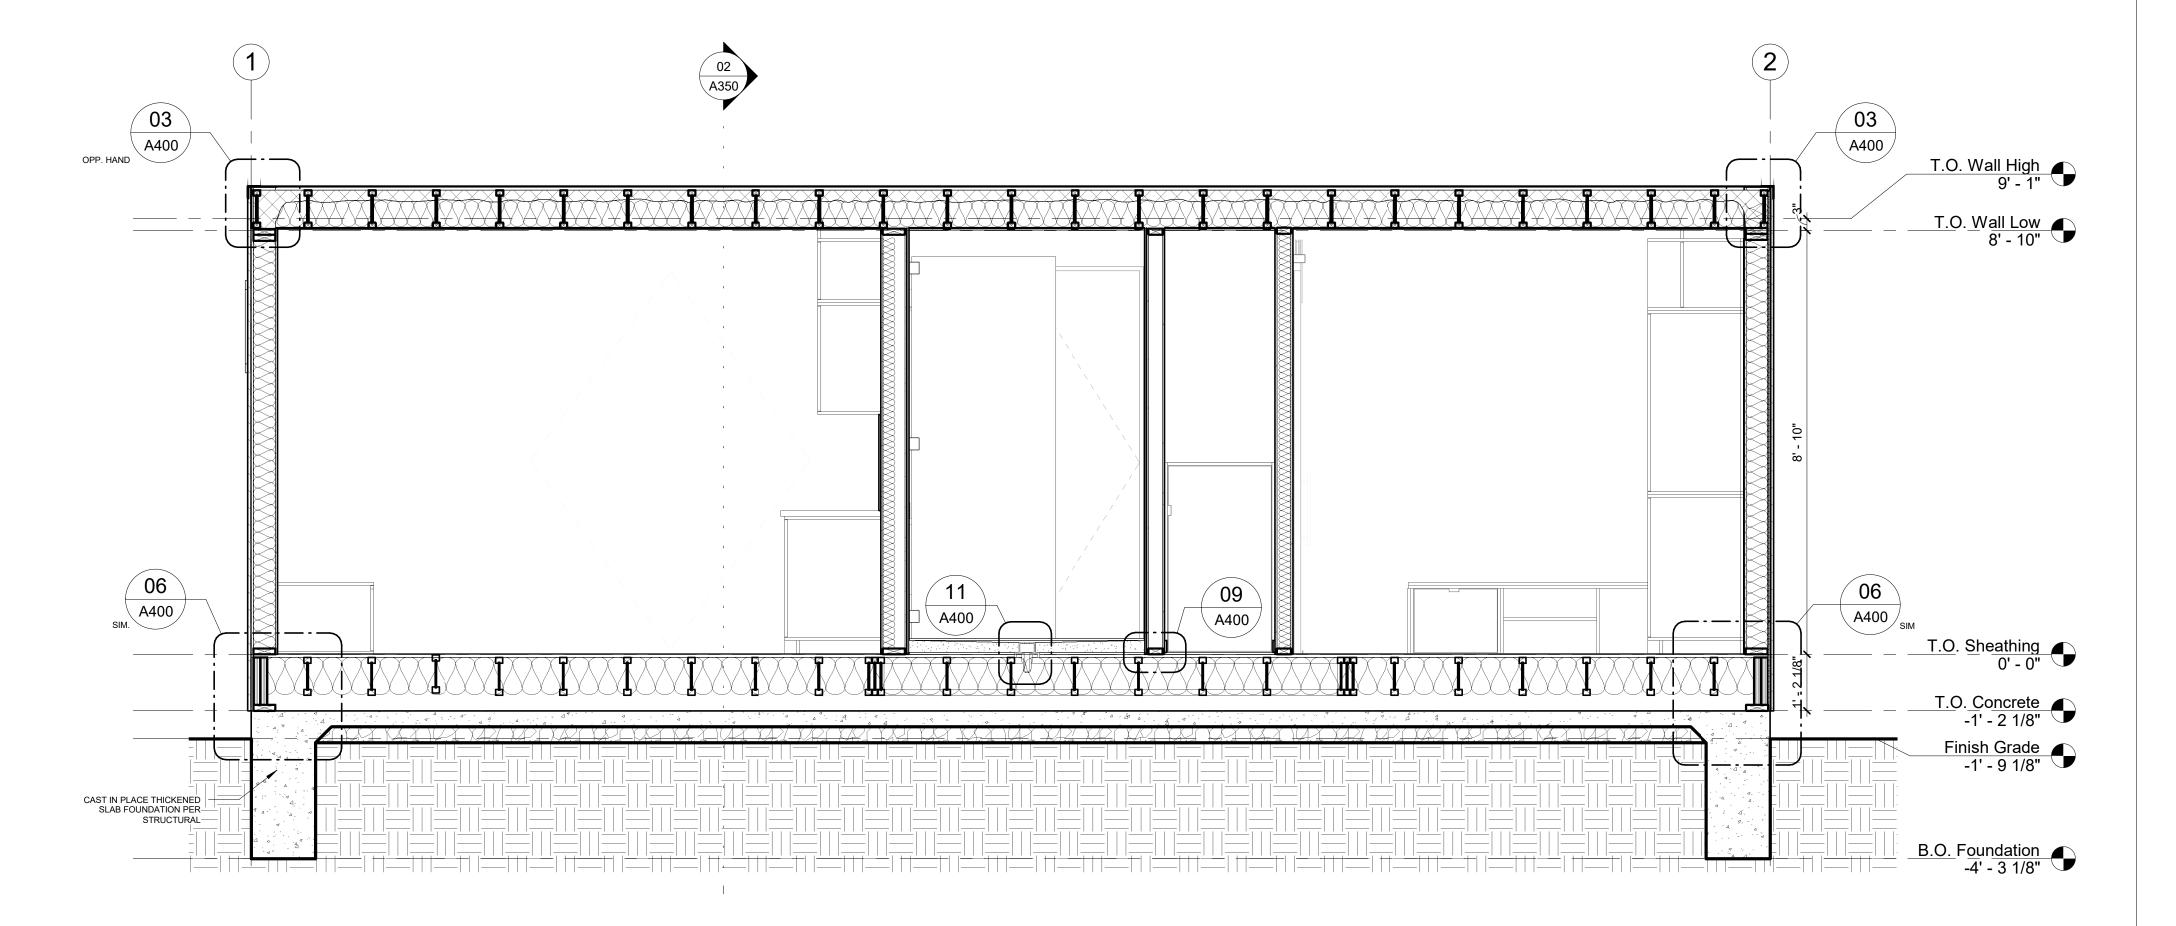


GENERAL NOTES - SECTIONS

- THESE BUILDING SECTIONS ARE SHOWN FOR SPACIAL RELATIONSHIPS ONLY AND SHOULD NOT BE SOLE BASIS FOR JOINING MATERIALS. REFER TO CALLOUT DETAILS OR ASK ARCHITECT IF UNCERTAIN OR IF CONFLICTS
- WHEN SHOWN IN ELEVATION OR SECTION, ALL DIMENSIONS ARE TO TOP OF PLATE, TOP OF CONCRETE, U.N.O
- DO NOT SCALE DRAWINGS. WRITTEN DIMENSIONS GOVERN.
 ALL CLEAR DIMENSIONS ARE NOT TO BE ADJUSTED WITHOUT APPROVAL


OF THE ARCHITECT.

LEGEND - SECTIONS

─ SHT. NO.

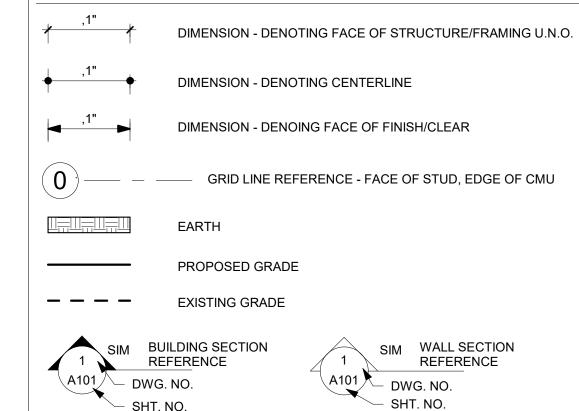

DWG. NO. SHT. NO.

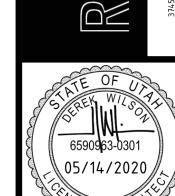



MOD 1072 S J

REVISION SETS MARK DATE

DRAWN BY 1K

BUILDING SECTIONS

EXTERIOR SIDING, SEE BUILDING

RANGE ARCHITECTURE | DESIGN
374.5 EAST HERMES DRIVE SLC, UT 84124
MANALD ANGENCHIPE COME SIC, OT 84124

6590963-0301 05/14/2020

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MODAL 01 ADU - WILLIAP 1072 S Jeremy St., Salt Lake City, UT 84104

PERMIT SET 05/14/2020

REVISION SETS
MARK
DATE

PLOT DATE 05/14/2020

PROJECT 2033

PROJECT 2033

PRAWN BY IK

CHECKED BY N/A

BUILDING DETAILS

SHEET TITLE

A400